CONSTRUCTION TYPE————————————————————————————————————
OCCUPANCY TYPE  NUMBER OF STORIES (LIVING AREA)—
STANDARD LOADINGS
REFER TO STRUCTURAL
BUILDING AREA:
MAIN RESIDENCE
MAIN LEVEL LIVING AREA
PATIO AREA———————————————————————————————————
BASEMENT LIVING AREA
LIVING AREA———————————————————————————————————
TOTAL MAIN RESIDENCE AREA
GUEST HOUSE
LIVING AREA PATIO AREA
GARAGE AREA
TOTAL GUEST HOUSE AREA
TOTAL AREA
ALL CONSTRUCTION SHALL COMPLY WIT
THE 2018 INTERNATIONAL RESIDENTIAL
<ul> <li>THE 2018 INTERNATIONAL BUILDING C</li> <li>THE 2018 INTERNATIONAL PLUMBING</li> </ul>
<ul> <li>THE 2018 INTERNATIONAL MECHANIC</li> </ul>
THE 2017 NATIONAL ELECTRIC CODE

## JECT INFORMATION

– TYPE VB JCTION TYPE----- GROUP R-3 ICY TYPE----OF STORIES (LIVING AREA)—— — 1 STORY w/ BASEMENT

### RD LOADINGS

### AREA:

### ESIDENCE

– 2730 SQ. FT. – 849 SQ. FT. E AREA-– 767 SQ. FT. — 2258 SQ. FT. - 774 SQ. FT. MAIN RESIDENCE AREA-– 7378 SQ. FT. HOUSE – 867 SQ. FT. - 305 SQ. FT. – 1437 SQ. FT. E AREA-

### STRUCTION SHALL COMPLY WITH

- 018 INTERNATIONAL RESIDENTIAL CODE (IRC)
- 018 INTERNATIONAL BUILDING CODE (IBC)
- 018 INTERNATIONAL PLUMBING CODE (IPC)
- 18 INTERNATIONAL MECHANICAL CODE (IMC)
- 17 NATIONAL ELECTRIC CODE (NEC)

# **GENERAL NOTES**

– 2609 SQ. FT.

- 9987 SQ. FT.

CONSTRUCTION SHALL CONFORM TO ALL ADOPTED CODES AND PRACTICES OF THE COMMUNITY OR AREA IN WHICH CONSTRUCTION TAKES PLACE

ALL STUMPS, ROOTS, AND ORGANIC MATTER SHALL BE REMOVED FROM

THE SOIL IN THE AREA OF THE BUILDING FABRICATORS AND ERECTORS TO PROTECT EXISTING STRUCTURES AND

FOUNDATIONS FROM DAMAGE DURING CONSTRUCTION FABRICATORS AND ERECTORS TO VERIFY ALL EXISTING DIMENSIONS AND GRADES IN THE FIELD BEFORE CONSTRUCTION

## **CONSTRUCTION NOTES**

REFER TO STRUCTURAL SPECIFICATIONS AND FOUNDATION PLAN FOR TREATMENT OF SOIL SUPPORTING FOUNDATION. ALL DRAINAGE FROM PROPERTY SHALL DRAIN INTO APPROVED DRAINAGE SYSTEM.

ALL EARTH FILL TO RECEIVE CONCRETE FLOORS, WALKS, DRIVEWAYS, ETC., SHALL BE SETTLED, TAMPED, AND HAVE 4" OF 3/4" ABC AGGREGATE AT 90% COMPACTION

ATTICS SHALL HAVE A MINIMUM ACCESS OPENING OF 22" X 30" WITH MINIMUM HEAD ROOM ABOVE ACCESS OPENING OF 30"

### WINDOWS

- 4. ALL WINDOWS (EXCEPT GARAGE OR OTHERWISE NOTED) SHALL BE VINYL WINDOWS w/ ARGON FILLED LOW-E GLASS OR EQUAL
- PROVIDE SCREENS FOR OPEN-ABLE SIDE OF ALL SLIDING WINDOWS OR GLASS SLIDING DOORS

### HEATING/VENTILATION/AIR CONDITIONING

. ALL HEATING AND VENTILATION EQUIPMENT SHALL BE INSTALLED IN ACCORDANCE WITH THE INTERNATIONAL MECHANICAL CODE. FURNACE AND WATER HEATER SHALL BE INSTALLED SUCH THAT THEY CAN BE INDIVIDUALLY REMOVED WITHOUT REMOVING THE OTHER

WATER HEATER AND FURNACE VENTS SHALL NOT TERMINATE WITHIN 10' HORIZONTALLY OR 3' ABOVE AN AIR CONDITIONING OR FORCED AIR INLET

### **PLUMBING**

CHIMNEY

S5.3

8. ALL TOILETS OR WATER CLOSETS SHALL BE LOW FLUSH TYPE (1.5 GALLONS PER FLUSH OR LESS). WATER CLOSET SHALL HAVE A MIN. OF 24' IN FRONT AND 30" WIDTH OF CLEARANCE

ABOVE GRADE AND SHALL NOT CONNECT TO ANY OTHER VENT DUCT OR

MAIN PLUMBING STACKS SHALL RUN UNDIMINISHED IN 3" OR LARGER AND DIRECT AS POSSIBLE FROM THE MAIN DRAIN TO THE OPEN AIR ABOVE THE ROOF. NO PLUMBING VENT SHALL TERMINATE LESS THAN 16" HORIZONTALLY OR 3" ABOVE ANY GRAVITY OR POWER AIR INLET 10. VENT DRYER TO OUTSIDE OF BUILDING. VENT HOOD SHALL BE 12" MIN.



#### SHEET INDEX SHEET TITLE TITLE SHEET A100 RESIDENCE MAIN FLOOR PLAN A101 RESIDENCE BASEMENT FLOOR PLAN A102 GUEST HOUSE FLOOR PLAN A103 RESIDENCE ROOF PLAN GUEST HOUSE ROOF PLAN A104 RESIDENCE ELEVATIONS A200 A201 RESIDENCE ELEVATIONS **GUEST HOUSE ELEVATIONS** A202 A300 RESIDENCE CROSS SECTIONS **GUEST HOUSE CROSS SECTIONS** A301 A400 SCHEDULES ELECTRICAL COVER SHEET E0.1 E0.2 ELECTRICAL SPECIFICATIONS E0.3 ELECTRICAL PANEL SCHEDULE E0.4 ELECTRICAL RESIDENTIAL CALCULATIONS E1.0 ELECTRCAL POWER PLAN - MAIN LEVEL E1.1 ELECTRICAL POWER PLAN - BASEMENT E1.2 ELECTRICAL POWER PLAN - GUEST HOUSE E2.0 ELECTRICAL LIGHTING PLAN - MAIN LEVEL E2.1 ELECTRICAL LIGHTING PLAN - BASEMENT E2.2 ELECTRICAL LIGHTING PLAN - GUEST HOUSE S0.1 STRUCTURAL SPECIFICATIONS S1.0 RESIDENCE FOUNDATION PLAN GUEST HOUSE FOUNDATION PLAN S1.1 RESIDENCE MAIN FLOOR FRAMING PLAN S3.0 RESIDENCE ROOF FRAMING PLAN S3.1 GUEST HOUSE ROOF FRAMING PLAN FOUNDATION DETAILS S4.0 FOUNDATION DETAILS S4.1 SHEET: S5.0 FRAMING DETAILS FRAMING DETAILS S5.1 FRAMING DETAILS S5.2


FRAMING DETAILS




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> H S



HRR DRAWN BY: NTS SCALE:

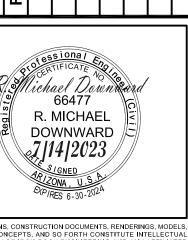

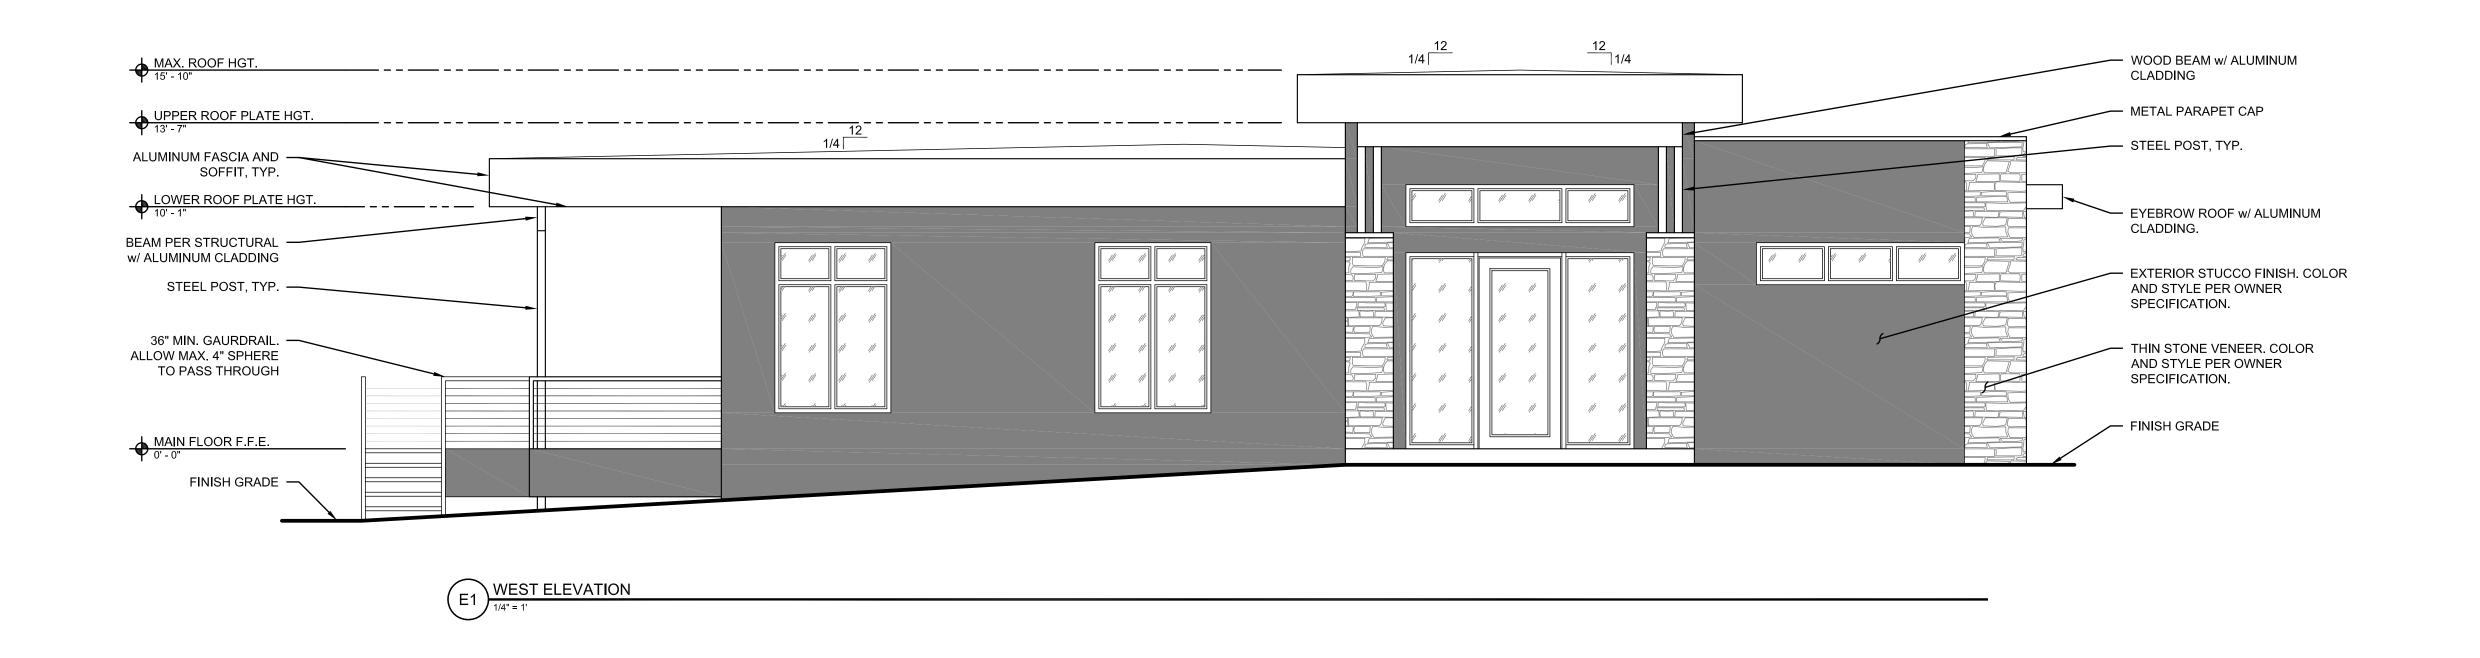

NORTH ELEVATION

1/4" = 1'

IRON ROCK
GROUP

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> RESIDENCE ELEVATIONS

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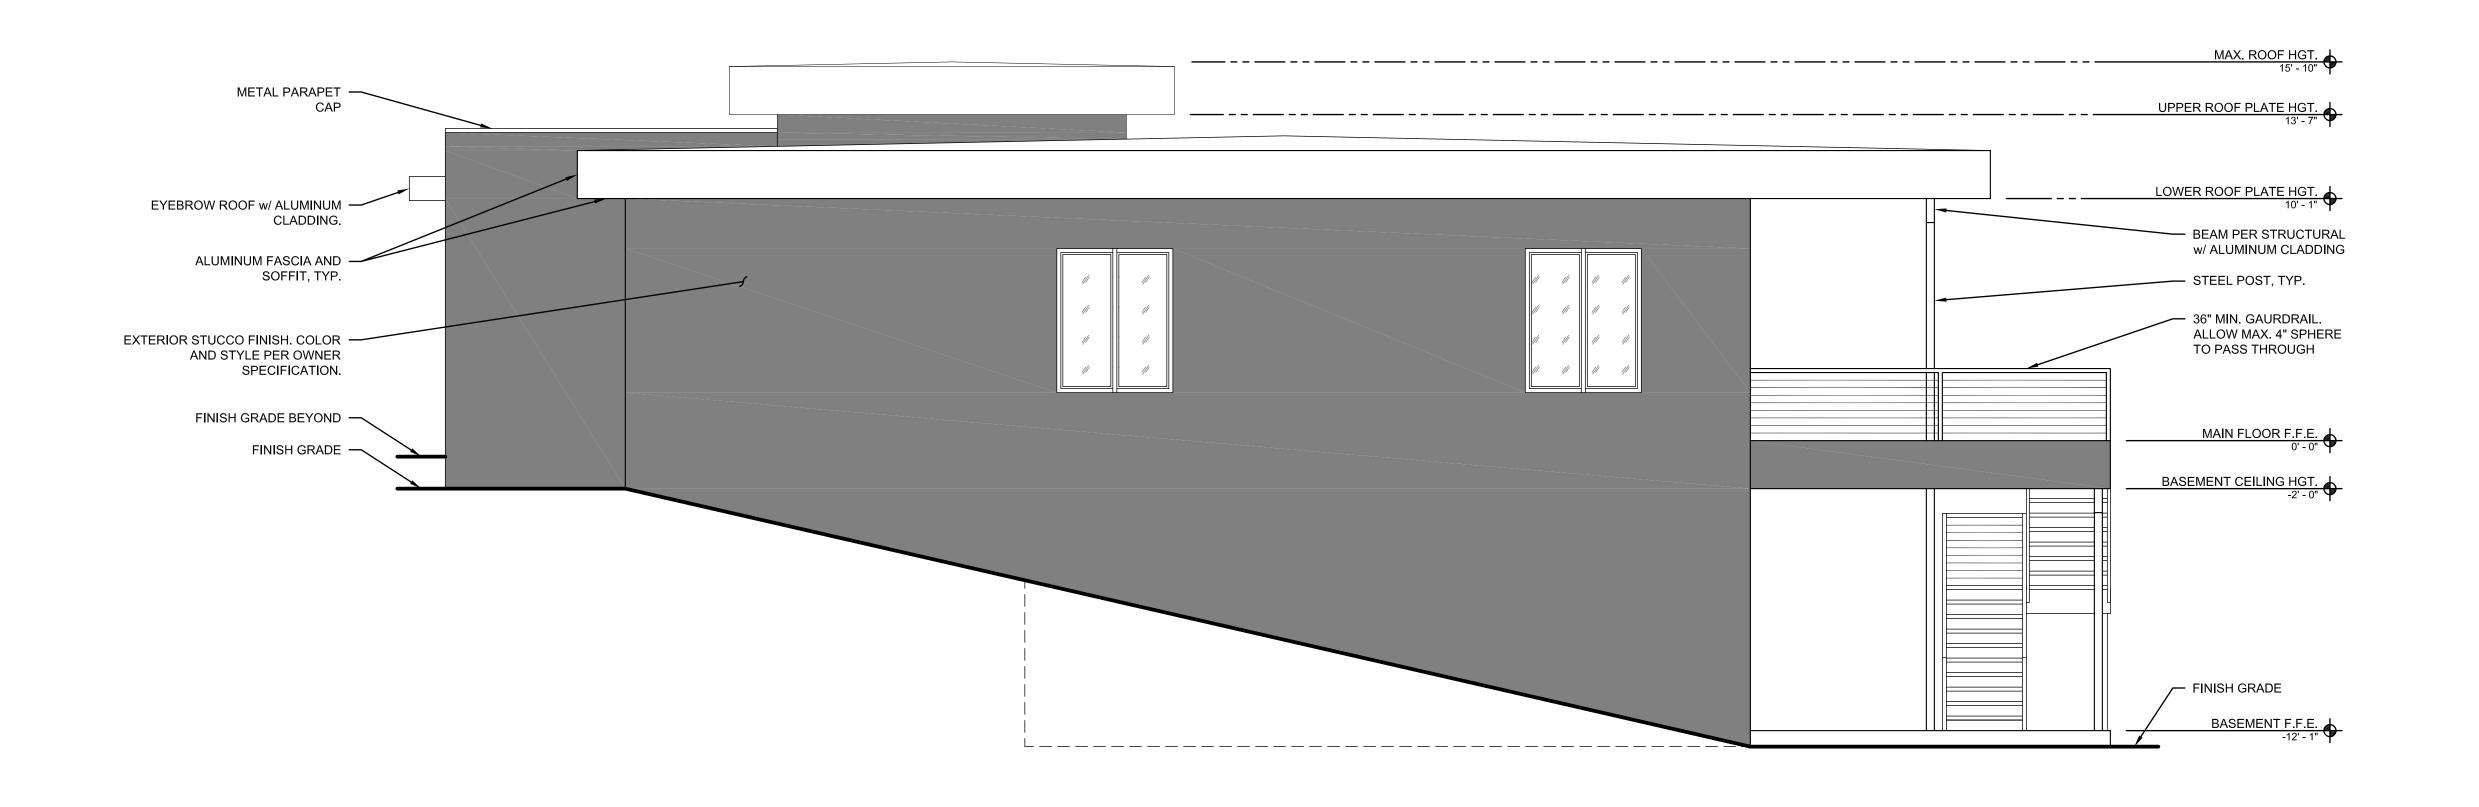
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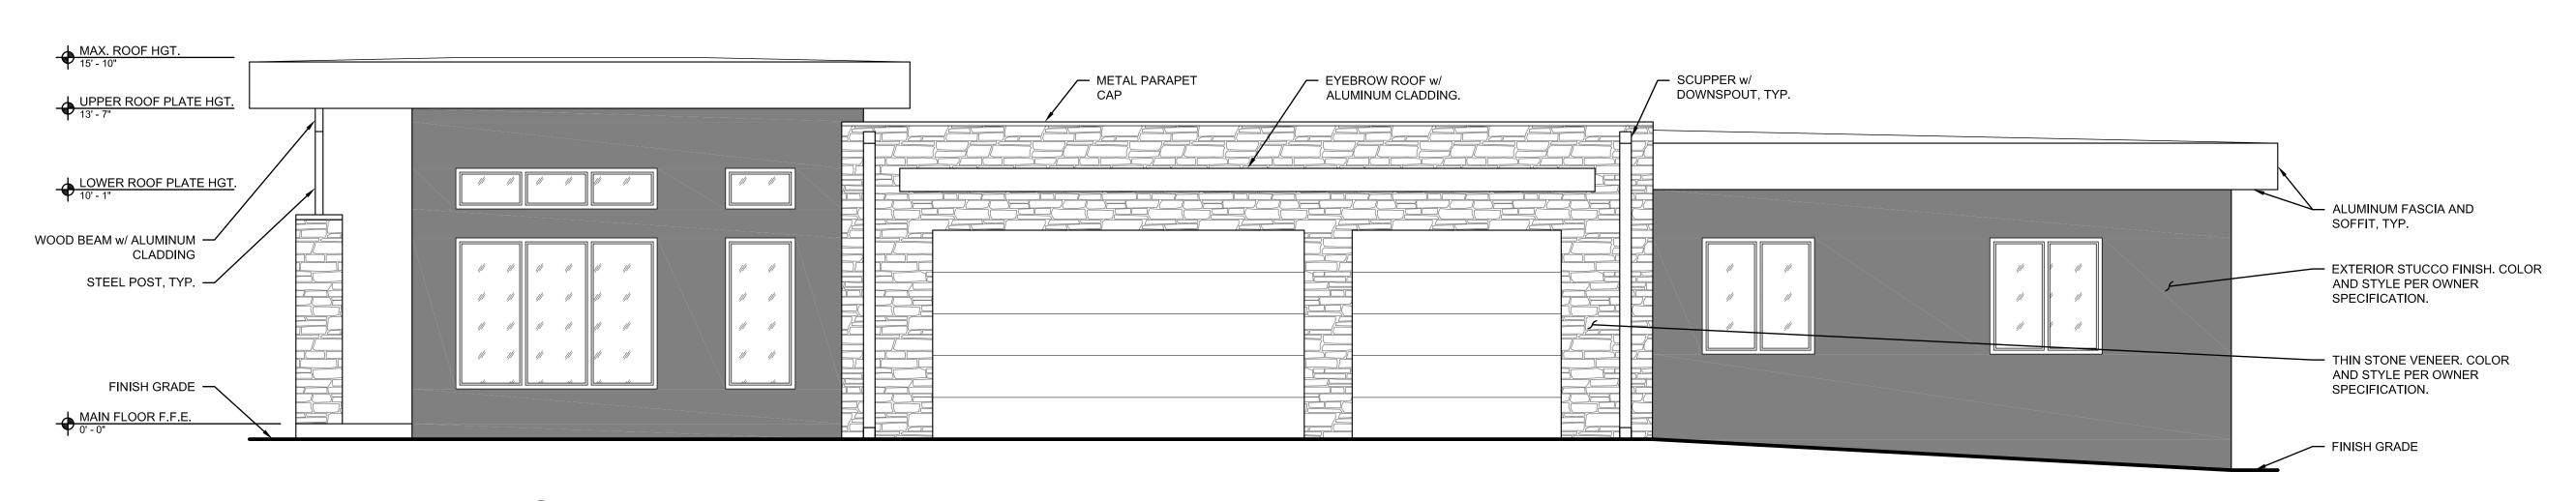
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E3) EAST ELEVATION



SOUTH ELEVATION

1/4" = 1'

IRON ROCK
GROUP

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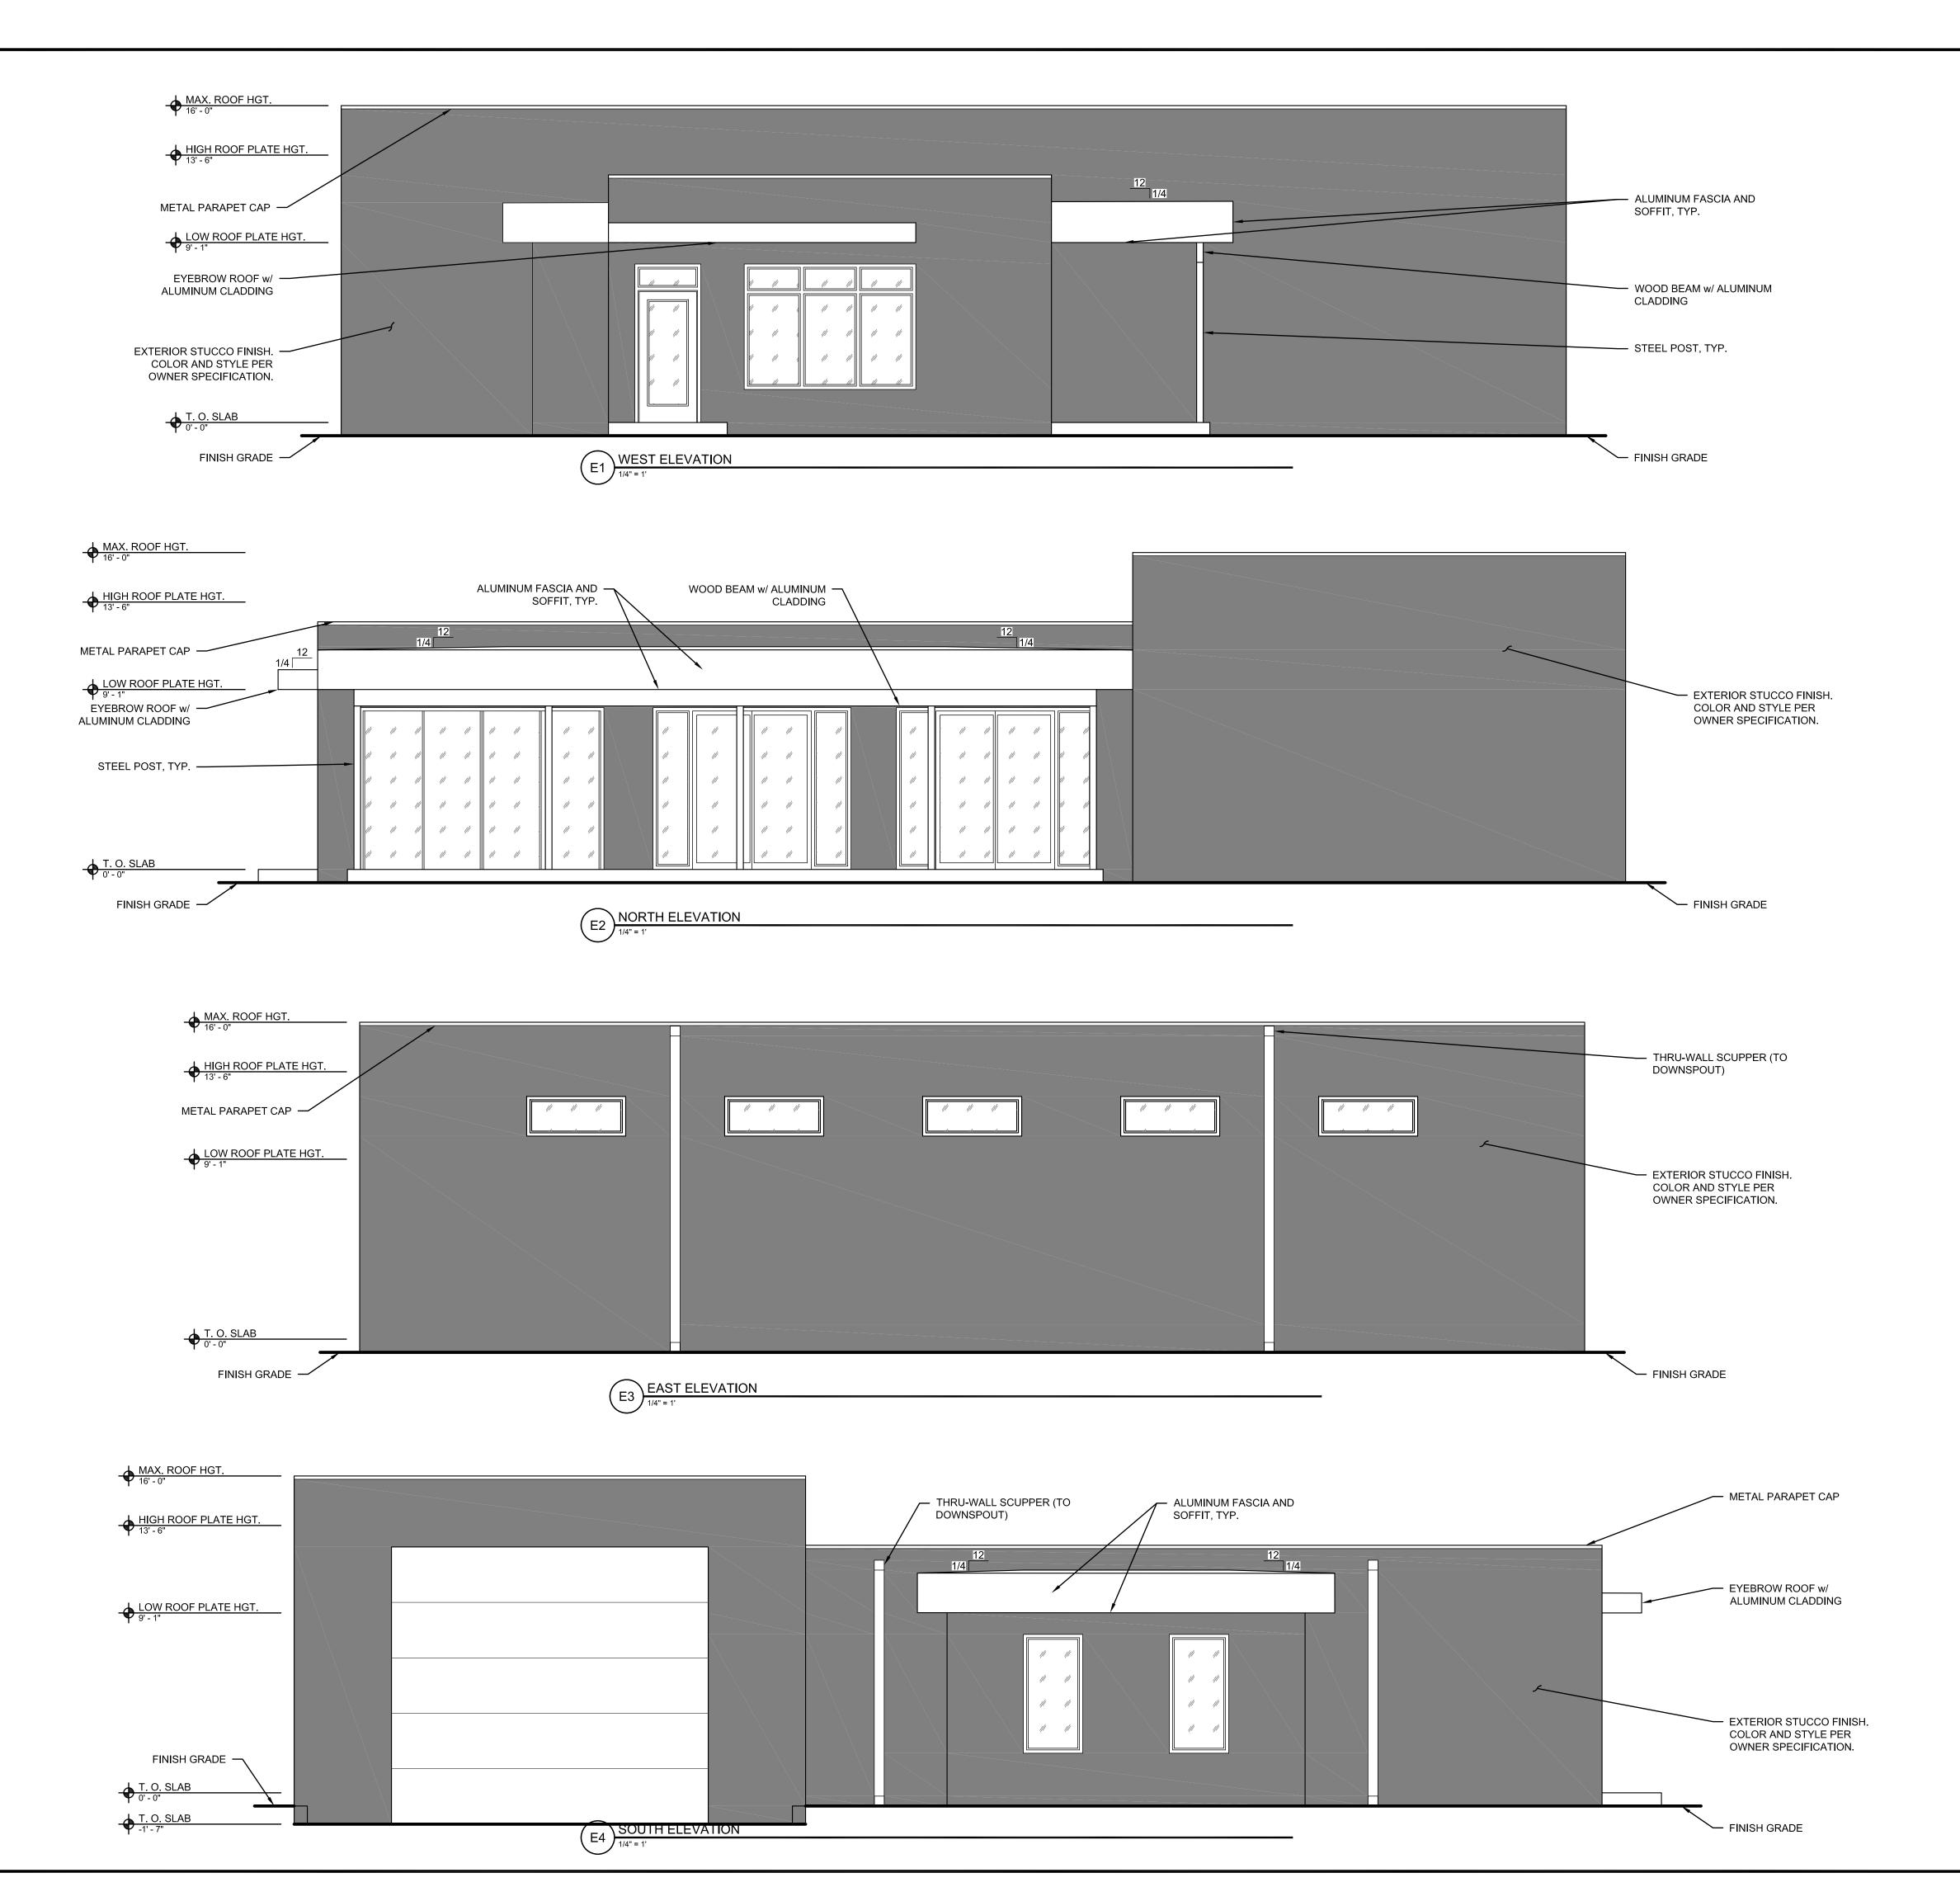
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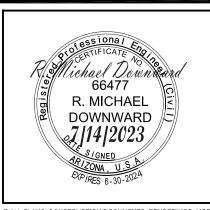
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GUEST HOUSE ELEVATIONS

INITIAL SUBMITTAL: 07/14/2023

REV#: DATE: DESCRIPTION:



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